VILLAGE OF NEW GLARUS PLAN COMMISSION MEETING AGENDA Village Hall Board Room 319 2nd St.

6/21/2023 6:00 PM

Zoom Meeting Link: https://us02web.zoom.us/j/86846604470

REGULAR MEETING

- 1. Call to Order
- 2. Approval of Agenda
- 3. Approval of Minutes –April 19, 2023
- 4. Consideration/Discussion: New Glarus Primary School and Track & Field Project Overview
- 5. Set next meeting date for Wednesday, July 26 at 6:00 PM
- 6. Adjournment

Roger Truttmann, Chair Village Plan Commission

POSTED:

N.G. Village Hall 6/16/23 N.G. Post Office 6/16/23 Bank of New Glarus 6/16/23

Kelsey A. Jenson, Clerk

PURSUANT TO APPLICABLE LAW, NOTICE IS HEREBY GIVEN THAT A QUORUM OR A MAJORITY OF THE NEW GLARUS VILLAGE BOARD TRUSTEES MAY ATTEND THIS MEETING. INFORMATION PRESENTED AT THIS MEETING MAY HELP FORM THE RATIONALE BEHIND FUTURE ACTIONS THAT MAY BE TAKEN BY THE NEW GLARUS VILLAGE BOARD.

PERSONS REQUIRING ADDITIONAL SERVICES TO PARTICIPATE IN A PUBLIC MEETING MAY CONTACT THE VILLAGE CLERK FOR ASSISTANCE AT 527-2510

VILLAGE OF NEW GLARUS PLAN COMMISSION MEETING MINUTES

Village Hall Board Room 319 2nd Street April 19, 2023 6:30 PM

<u>REGULAR MEETING CALL TO ORDER</u>: Chair Roger Truttman, called regular meeting to order at 6:30 p.m.

PRESENT: Roger Truttmann, Bekah Stauffacher, Chuck Phillipson, Beth Alderman, Suzi Janowiak, & Mike Marty

ALSO PRESENT: Village Administrator Lauren Freeman, Andrew Kerr (Bray Architects), Jennifer Thayer (School District of New Glarus), Travis Zimmerman (School District of New Glarus)

<u>APPROVAL OF AGENDA</u>: Motioned by Mike Marty, seconded by Suzi Janowiak. Motioned carried unanimously 6-0.

<u>APPROVAL OF MINUTES FROM 3.15.23:</u> Motioned by Bekah Stauffacher, seconded by Beth Alderman. Motioned carried unanimously 6-0.

CONSIDERATION/DISCUSSION:

New Glarus Middle & High School Addition Site Plan. After discussion, motion to approve with stipulations outlined in the Village Engineer's memo by Mike Marty, seconded by Beth Alderman. Motion carried 6-0.


Set next meeting date for Wednesday, May 17 at 6:00 PM.

ADJOURN: The meeting was adjourned at 6:43 p.m.

-Lauren FreemanVillage Administrator






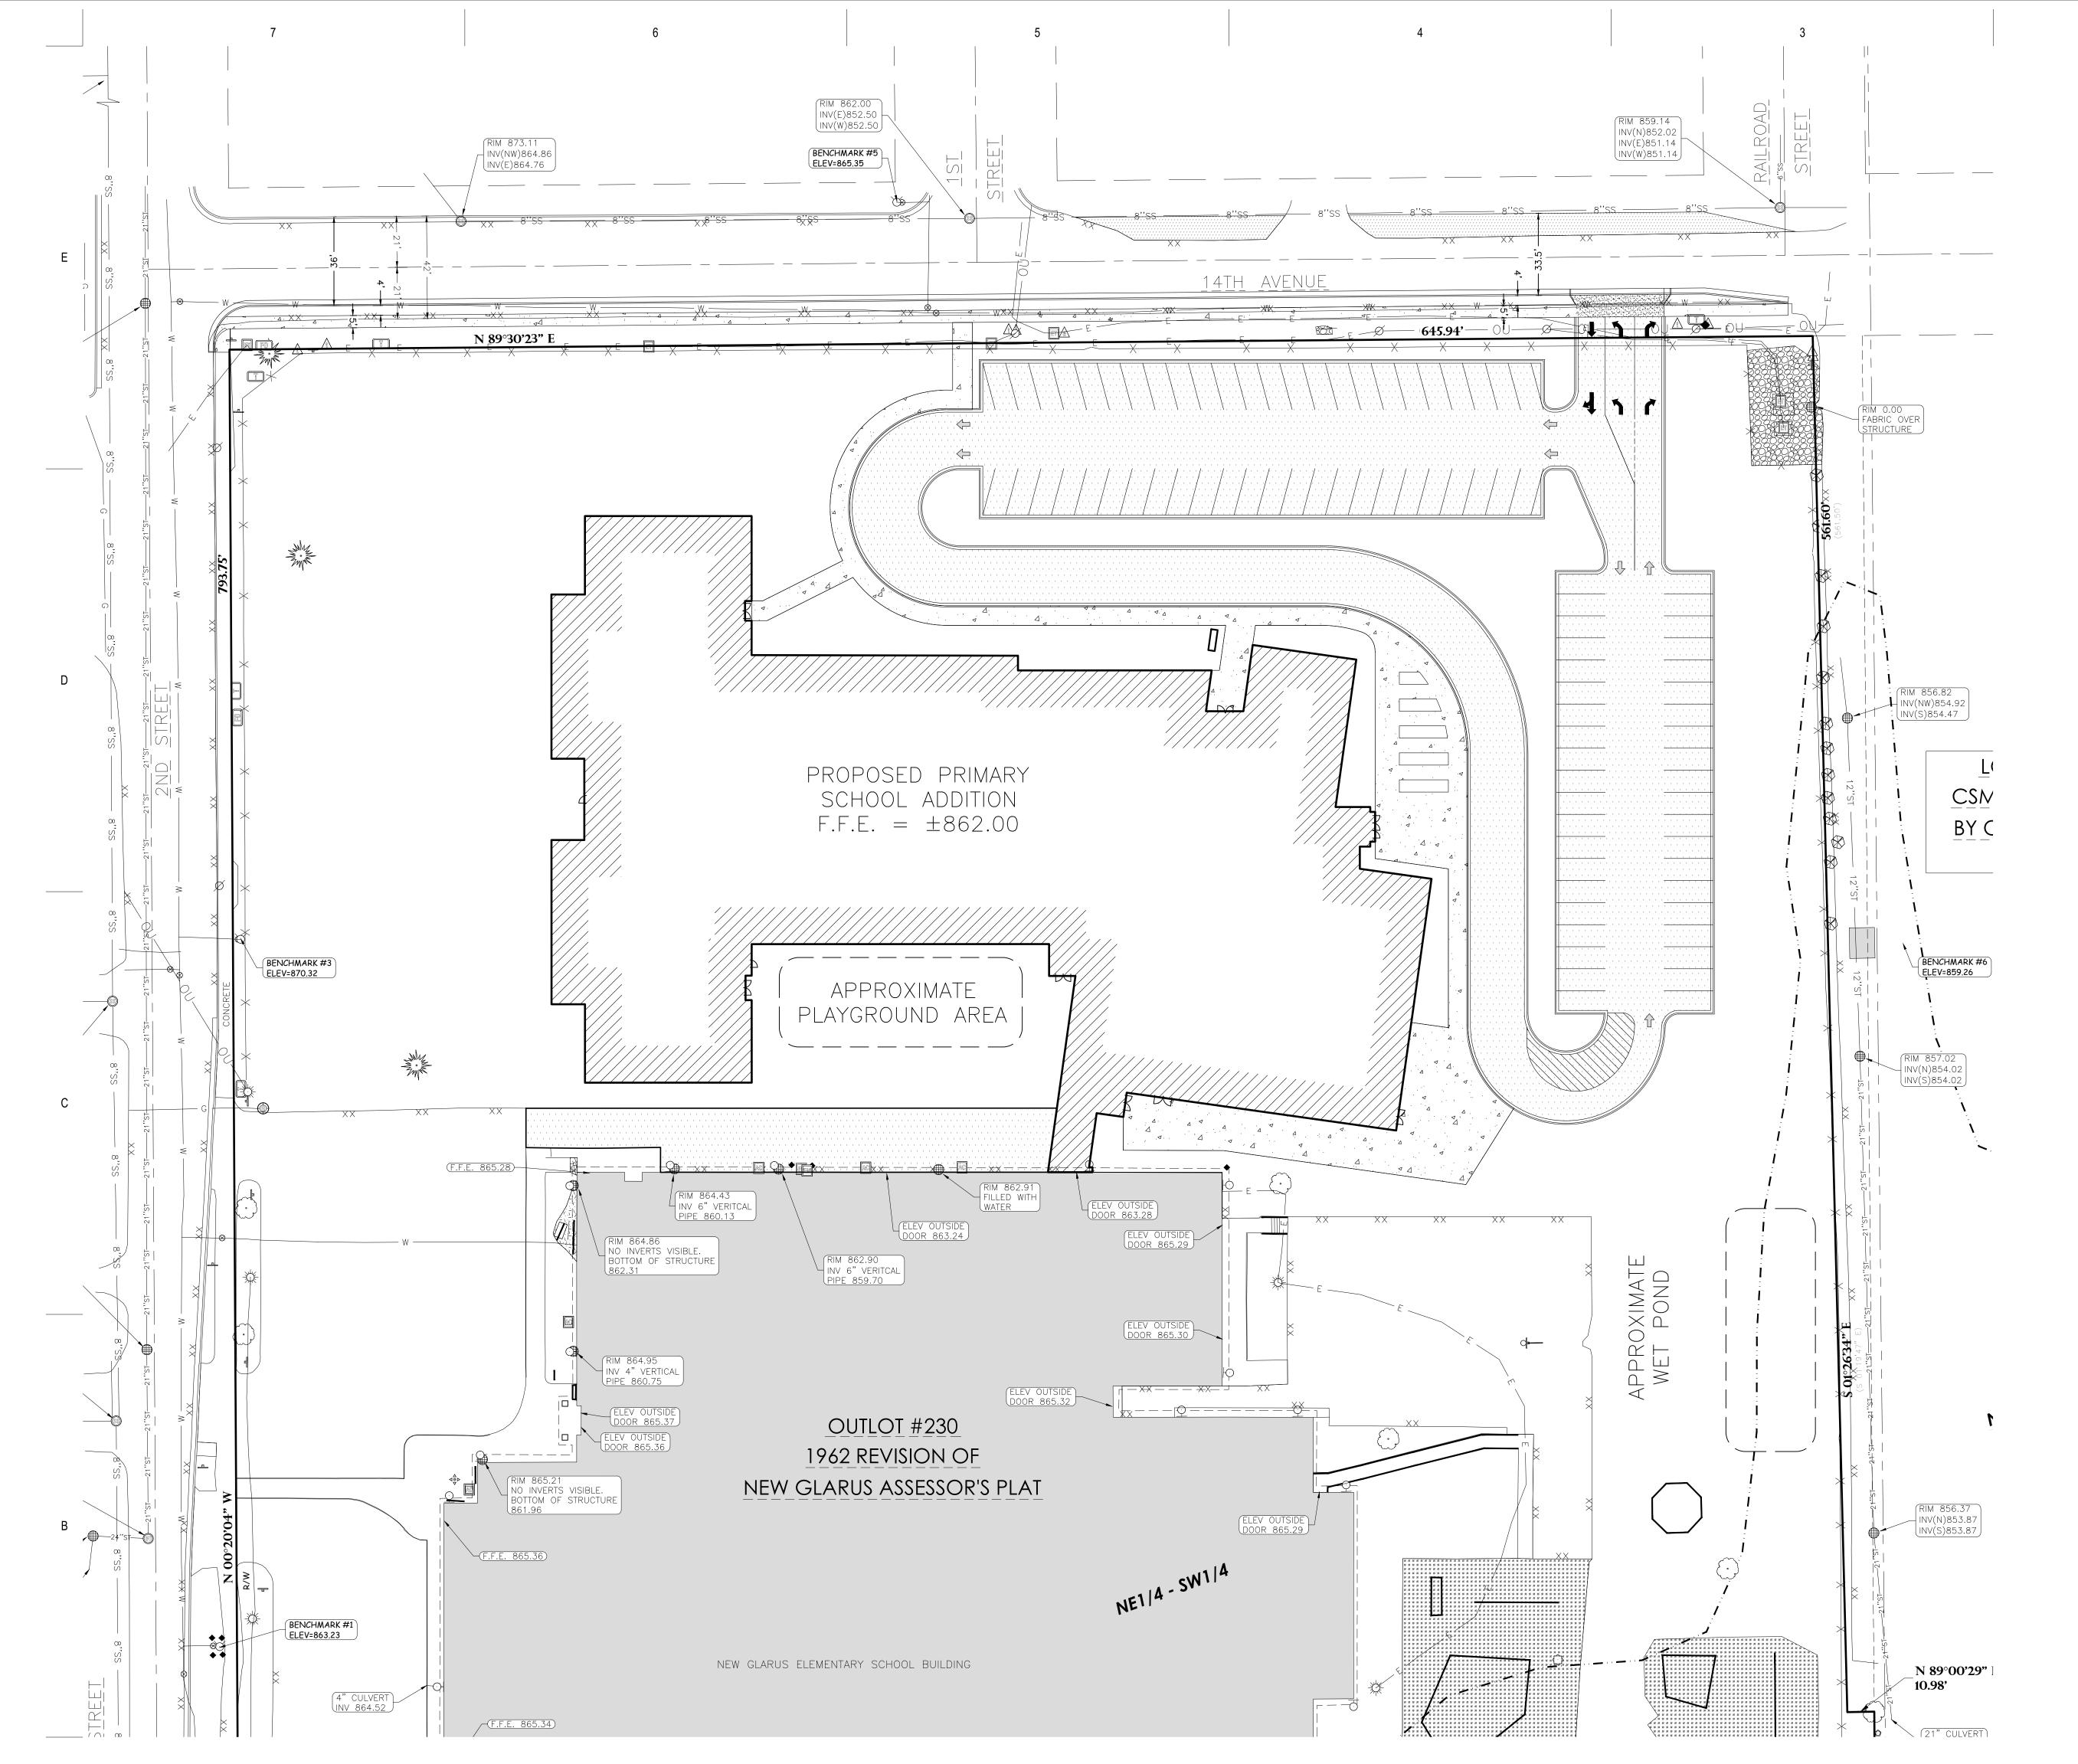

GENERAL NOTES:

- 1. CONTACT DIGGER'S HOTLINE 5 WORKING DAYS PRIOR TO THE START OF
- DEMOLITION/CONSTRUCTION.
 2. GRADE, LINE, AND LEVEL TO BE REVIEWED IN THE FIELD BY THE CONSTRUCTION
- 3. ALL REQUIRED EROSION CONTROL MEASURES SHALL BE INSTALLED AND MAINTAINED IN ACCORDANCE WITH VILLAGE OF NEW GLARUS AND DEPARTMENT OF NATURAL RESOURCES REGULATIONS.
- 4. SEE SHEET C4.0 FOR ALL REQUIRED EROSION CONTROL ELEMENTS. 5. ANY EXISTING UTILITIES NOT SHOWN ON THIS DOCUMENT WHICH NEED TO BE REMOVED, RELOCATED AND OR ADJUSTED SHALL BE THE RESPONSIBILITY OF THE SITE GRADING CONTRACTOR AND INCLUDED IN THE BASE BID CONTRACT.
- 6. VERIFY THE LOCATION OF ALL EXISTING UTILITIES PRIOR TO THE START OF DEMOLITION/CONSTRUCTION. 7. BIDDERS SHALL VISIT THE SITE AND REVIEW EXISTING CONDITIONS PRIOR TO THE BID
- 8. PRIOR TO STARTING WORK, VERIFY WITH THE VILLAGE OF NEW GLARUS THAT ALL
- REQUIRED PERMITS HAVE BEEN ACQUIRED. 9. COORDINATE CONSTRUCTION IN THE RIGHT OF WAY WITH THE VILLAGE OF NEW GLARUS.
 10. PROVIDE PROPER BARRICADES, SIGNS, AND TRAFFIC CONTROL TO MAINTAIN THRU
 TRAFFIC ALONG ADJACENT STREETS IN ACCORDANCE WITH VILLAGE OF NEW GLARUS
- REQUIREMENTS. 11. SIDEWALK JOINTS SHALL BE INSTALLED AS INDICATED OR AS APPROVED BY THE
- CONSTRUCTION MANAGER. 12. ALL CONCRETE SAWCUTS SHALL BE AT AN EXISTING JOINT.
- 13. ALL GENERAL LANDSCAPE AREAS SHALL BE SEEDED, FERTILIZED, AND CRIMP HAY MULCHED IN ACCORDANCE WITH THE PROJECT SPECIFICATIONS. 14. BLASTING OF ROCK IS NOT ALLOWED WITHOUT A BLASTING PERMIT FROM THE VILLAGE.

PAVEMENT HATCH PATTERNS:

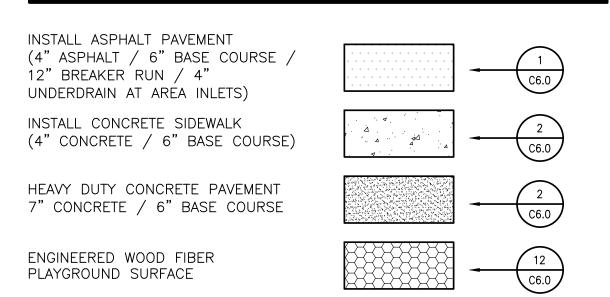





Davenport

Milwaukee 829 S. 1st Street Milwaukee, Wisconsin 53204

T: 414.226.0200

220 Emerson Place, Suite 301 Davenport, Iowa 52801

Sheboygan 1227A North 8th Street PO Box 955 Sheboygan, Wisconsin 53082

www.brayarch.com

T: 920.459.4200



REVISIONS:

Project Number: 3388


Issued For: SCHEMATIC DESIGN


> Sheet Title: **LAYOUT** PLAN

6/2/2023

Sheet Number:

© 2021 Bray Associates Architects, Inc.

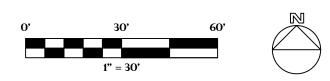

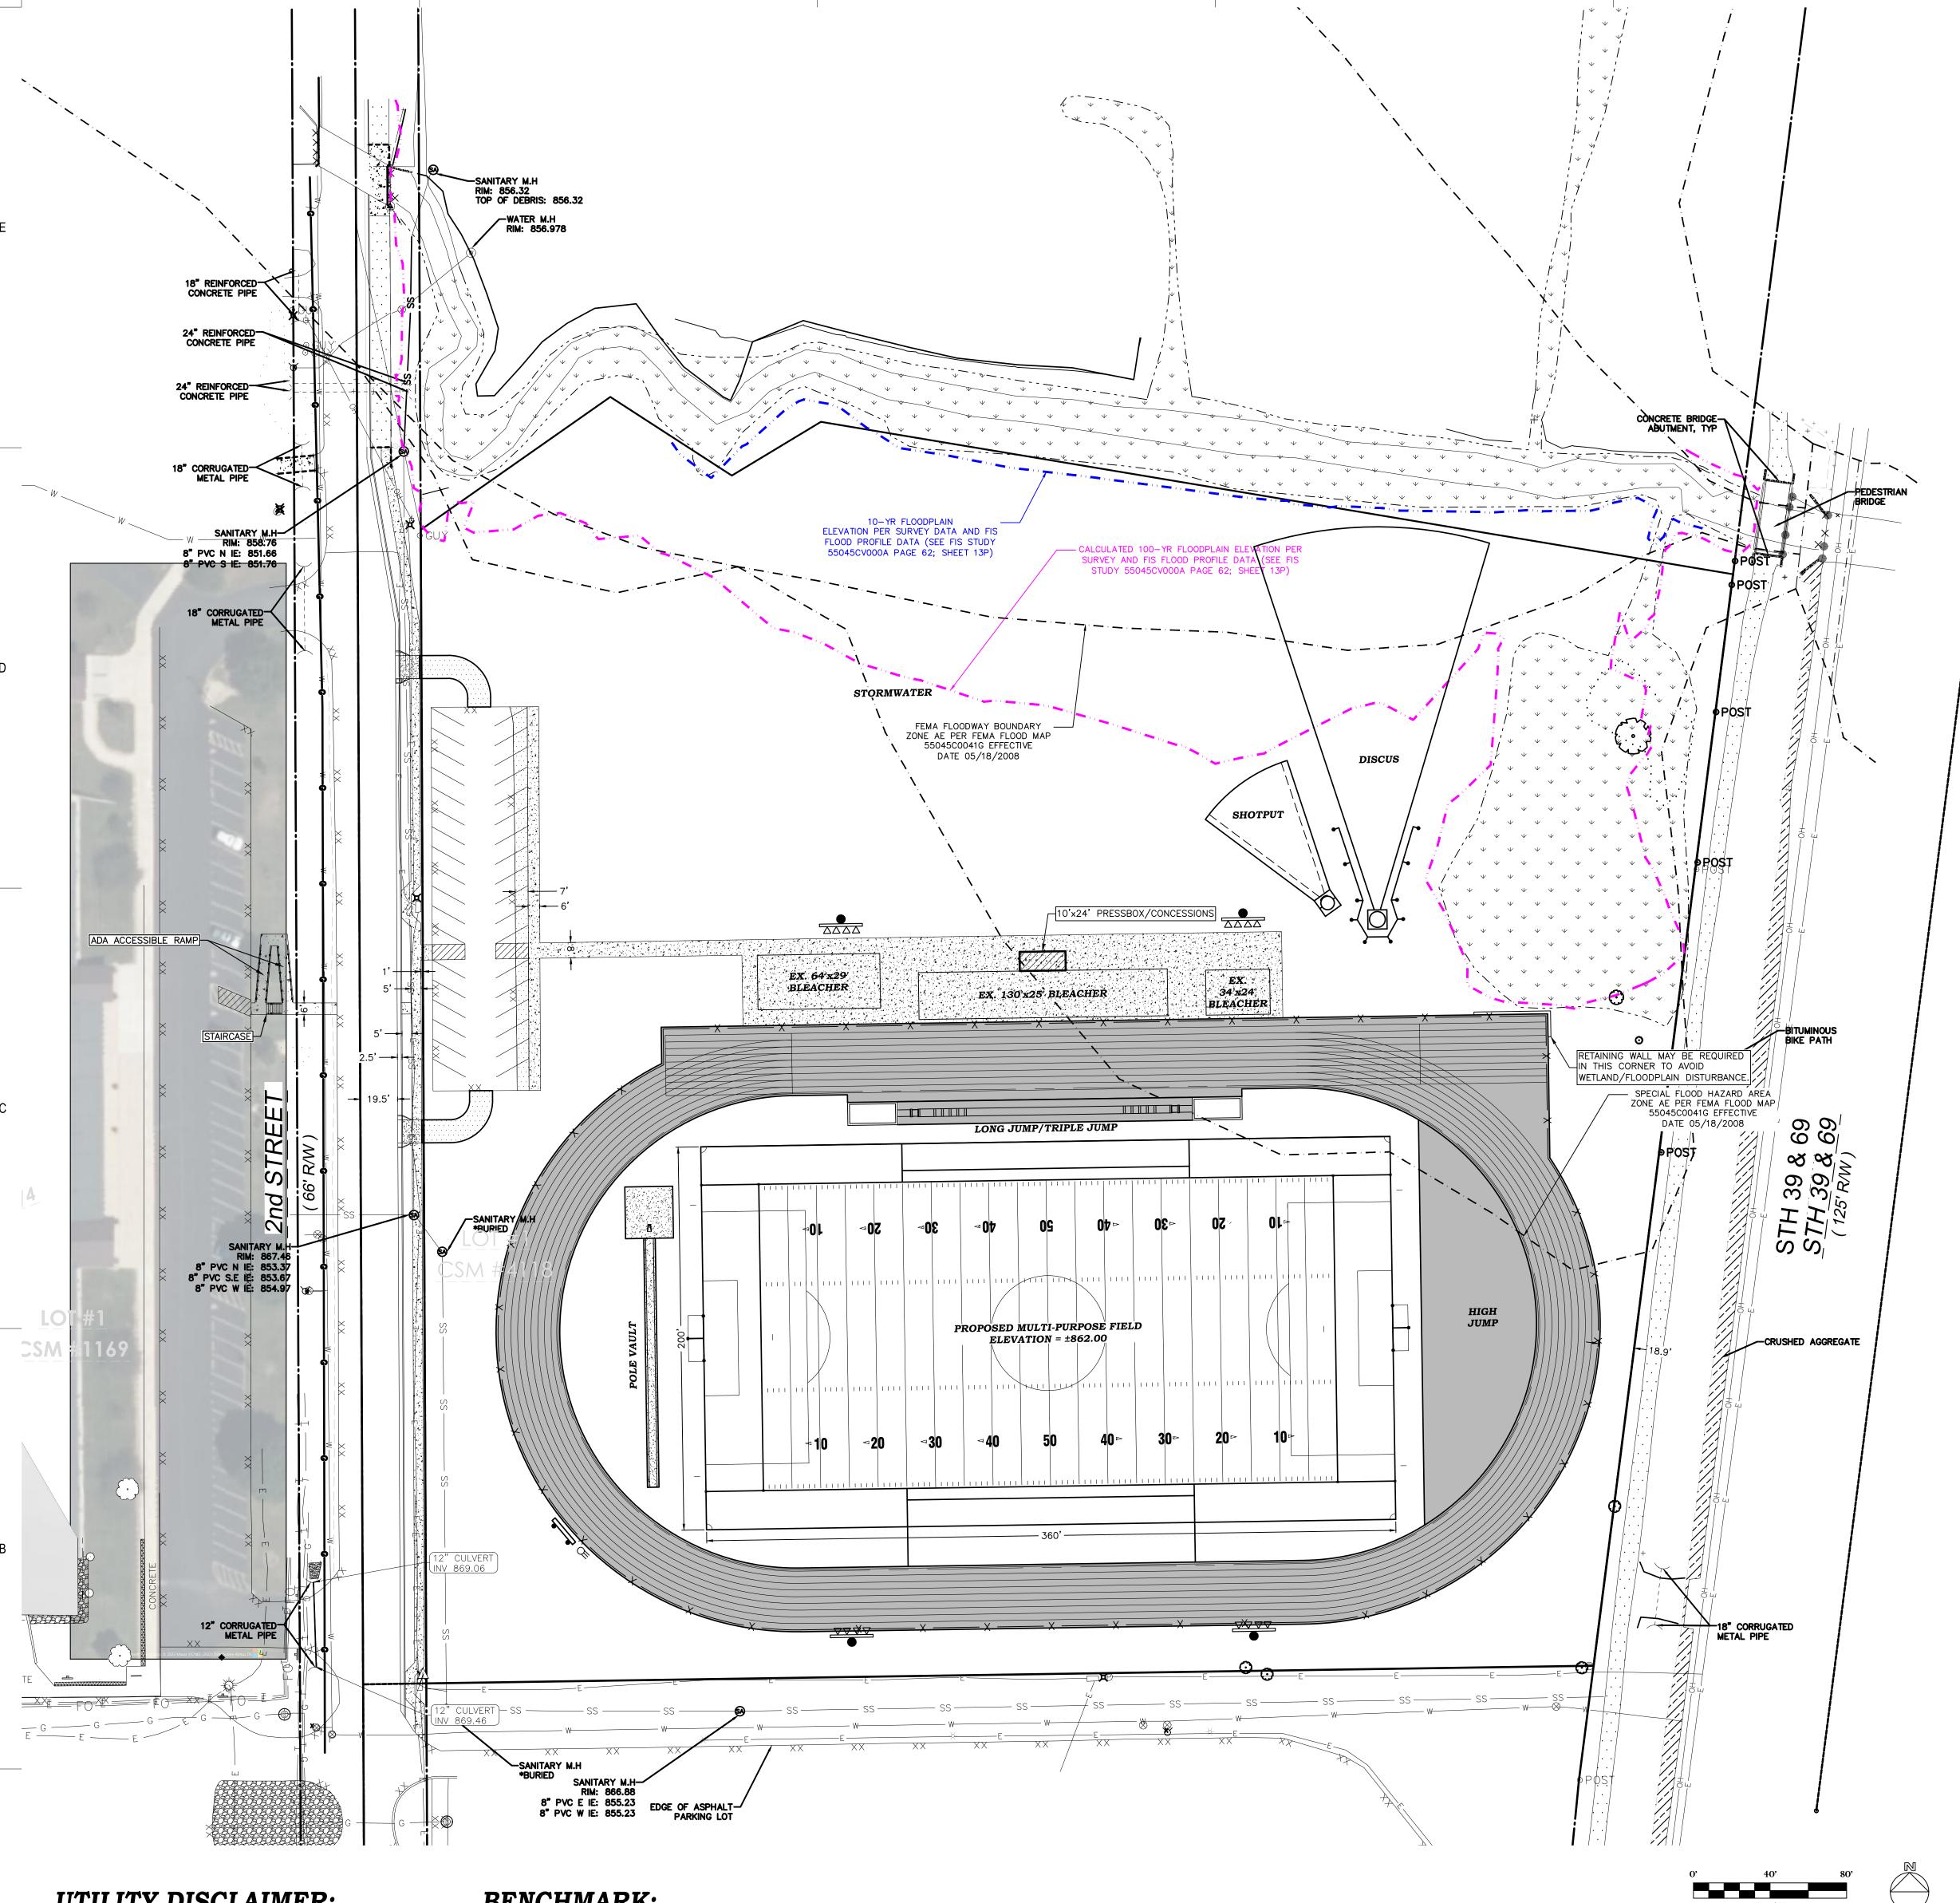

GENERAL NOTES:

- 1. CONTACT DIGGER'S HOTLINE 5 WORKING DAYS PRIOR TO THE START OF DEMOLITION/CONSTRUCTION. . GRADE, LINE, AND LEVEL TO BE REVIEWED IN THE FIELD BY THE CONSTRUCTION MANAGER. 3. ALL REQUIRED EROSION CONTROL MEASURES SHALL BE INSTALLED AND MAINTAINED IN ACCORDANCE WITH LOCAL MUNICIPAL AND DEPARTMENT OF NATURAL RESOURCES REGULATIONS.
- 4. SEE SHEET ___ FOR ALL REQUIRED EROSION CONTROL ELEMENTS. 5. ANY EXISTING UTILITIES NOT SHOWN ON THIS DOCUMENT WHICH NEED TO BE REMOVED, RELOCATED AND OR ADJUSTED SHALL BE THE RESPONSIBILITY OF THE SITE GRADING CONTRACTOR AND INCLUDED IN THE
- BASE BID CONTRACT. 6. VERIFY THE LOCATION OF ALL EXISTING UTILITIES PRIOR TO THE START OF DEMOLITION/CONSTRUCTION.
- 7. BIDDERS SHALL VISIT THE SITE AND REVIEW EXISTING CONDITIONS PRIOR TO THE BID DATE. 8. PRIOR TO STARTING WORK, VERIFY WITH THE LOCAL AUTHORITIES THAT ALL REQUIRED PERMITS HAVE
- BEEN ACQUIRED. 9. COORDINATE CONSTRUCTION IN THE RIGHT OF WAY WITH THE LOCAL AUTHORITIES.
- 10. PROVIDE PROPER BARRICADES, SIGNS, AND TRAFFIC CONTROL TO MAINTAIN THRU TRAFFIC ALONG ADJACENT STREETS IN ACCORDANCE WITH LOCAL MUNICIPAL REQUIREMENTS.
- 11. SIDEWALK JOINTS SHALL BE INSTALLED AS INDICATED OR AS APPROVED BY THE CONSTRUCTION MANAGER. 12. ALL GENERAL LANDSCAPE AREAS SHALL BE SEEDED, FERTILIZED, AND CRIMP HAY MULCHED IN
- ACCORDANCE WITH THE PROJECT SPECIFICATIONS.

EXECUTE:

1. THICKENED EDGE WALK	XXX	20. MONUMENT SIGN (SEE ARCHITECTURAL PLANS)	XXX
2. 12"x18" CONCRETE CURBING	${\left(\begin{array}{c} xxx \\ xxx \end{array}\right)}$	24 DIVE DAOK (CEE CDECIFICATIONS	${}$ $\left(\begin{array}{c} xxx \\ xxx \end{array}\right)$
3. 6"x18" CONCRETE CURBING	XXX	21. BIKE RACK (SEE SPECIFICATIONS VERIFY FINAL LOCATION WITH ARCHITECT)	XXX
4. 12"x18" TO 6"x18" CONCRETE CURBING TRANSITION POINT	XXX	22. CONCRETE TRANSFORMER PAD	XXX
5. 18" CONCRETE CURB & GUTTER	- (XXX) XXX	23. TEMPORARY LAY—DOWN AREA (SEE SPECIFICATIONS FOR DETAILS)	XXX XXX XXX
6. 18" CONCRETE CURB & GUTTER (REJECT)	XXX	24. DUMPSTER ENCLOSURE (12'x22' CONCRETE PAD) (SEE	XXX
7. 24" CURB & GUTTER	XXX XXX XXX	ARCHITECTURAL PLANS) 25. FLAG POLE	XXX XXX XXX
8. 6" CURB TAPER SECTION	XXX	26. DIRECTIONAL SIGNAGE	XXX
9. STANDARD CURB TO REJECT CURB TRANSITION POINT	XXX	27. LIGHT POLE	XXX
10. CONCRETE DRIVE APRON	XXX	28. CONCRETE BOLLARD	XXX
11. HANDICAP RAMP	XXX	29. EXISTING TREE TO REMAIN	XXX
12. PARKING LOT STRIPING	XXX	30. FUTURE ADDITION	XXX
13. DIRECTIONAL ARROW	XXX	31. DOUBLE-SIDED ELECTRIC DIRECTIONAL SIGN	XXX
14. HANDICAP PARKING STALL	XXX	72 DDODOCED DETAINING WALL	(XXX)
15. HANDICAP PARKING SIGN	XXX	32. PROPOSED RETAINING WALL33. STOP SIGN	XXX
16. 8' PARKING STOP	XXX	34. ONE WAY SIGN	XXX
17. ADA ACCESS ROUTE	XXX	35. DO NOT ENTER SIGN	XXX
18. LOW-EMITTING/FUEL EFFICIENT VEHICLE PARKING SIGN	XXX XXX XXX	36. DOWEL CURBING TO EXISTING WITH 2-#5 AT 18". EMBEDDED 6" TYP.	

37. CONCRETE FLUME W/ RIP RAP

PAVEMENT HATCH PATTERNS:

INSTALL 3.5" ASPHALT PAVEMENT W/ 6" BASE W/ 12" BREAKER RUN


INSTALL 3.5" ASPHALT PAVEMENT W/ 6" BASE W/ 12" BREAKER RUN

W/ POLYURETHANE TRACK SURFACING

INSTALL 4" CONCRETE SIDEWALK

INSTALL 7" HEAVY DUTY CONCRETE PAVEMENT

19. LOW-EMITTING/FUEL EFFICIENT VEHICLE PARKING STALL

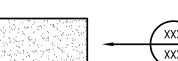

Project Number:

REVISIONS:

Office Locations:

Davenport

220 Emerson Place, Suite 301

Davenport, Iowa 52801

Milwaukee

Milwaukee, Wisconsin 53204

T: 414.226.0200

Sheboygan

1227A North 8th Street PO Box 955 Sheboygan, Wisconsin 53082 T: 920.459.4200

www.brayarch.com

829 S. 1st Street

Issued For: VILLAGE **MEETING**

> 6/14/2023 Sheet Title:

Sheet Number:

© 2021 Bray Associates Architects, Inc.

UTILITY DISCLAIMER:

THE LOCATIONS, SIZES, AND TYPES OF UNDERGROUND PUBLIC AND PRIVATE UTILITIES OR SUBSTRUCTURES SHOW HEREON WERE OBTAINED FROM VISUAL INSPECTION, FIELD MEASUREMENTS, AND/OR AS-BUILT PLANS. SANITARY SEWER AND STORM SEWER PIPE SIZES, INVERTS, DIRECTION, AND LOCATIONS BETWEEN MANHOLES ARE SUPPLEMENTED BY AS-BUILT PLANS AND/OR ESTIMATED BASED ON FIELD OBSERVATIONS. PRIOR TO CONSTRUCTION IN THE VICINITY OF ANY UTILITIES SHOWN HEREON, IT IS RECOMMENDED THAT THE LOCATIONS, DEPTHS, AND SIZES BE FIELD VERIFIED. THE LOCATIONS SHOWN HEREON ARE ONLY APPROXIMATE, WITH POSSIBILITY THAT ADDITIONAL UTILITY LINES NOT DISCOVERED, OR MARKED, DURING THE SEARCH OF RECORDS AND THE FIELD SURVEY MAY EXIST. ANY CONTRACTOR USING THE INFORMATION SHOWN HEREON IS HEREBY FOREWARNED THAT ANY EXCAVATION UPON THIS SITE MAY RESULT IN THE DISCOVERY OF ADDITIONAL UNDERGROUND UTILITIES NOT SHOWN HEREON. IN GENERAL, UNDERGROUND UTILITY LOCATIONS ARE SHOWN FROM UTILITY MARKINGS, BY OTHERS, AND/OR AS-BUILT PLANS, PROVIDED BY OTHERS. POINT OF BEGINNING MAKES NO WARRANTY OF ANY KIND, EXPRESS OR IMPLIED, WITH RESPECT TO THE EXISTING UTILITIES SHOWN HEREON,


AND BELIEVES THAT THE INFORMATION CONTAINED HEREIN IS RELIABLE

AND GENERALLY ACCURATE FOR THE PURPOSE INTENDED.

BENCHMARK:

BEARING ARE BASED ON WISCRS GREEN COUNTY

ZONE, (2012) VERTICAL DATUM NAVD 88. CONTACT KAPUR FOR BENCHMARK INFO.

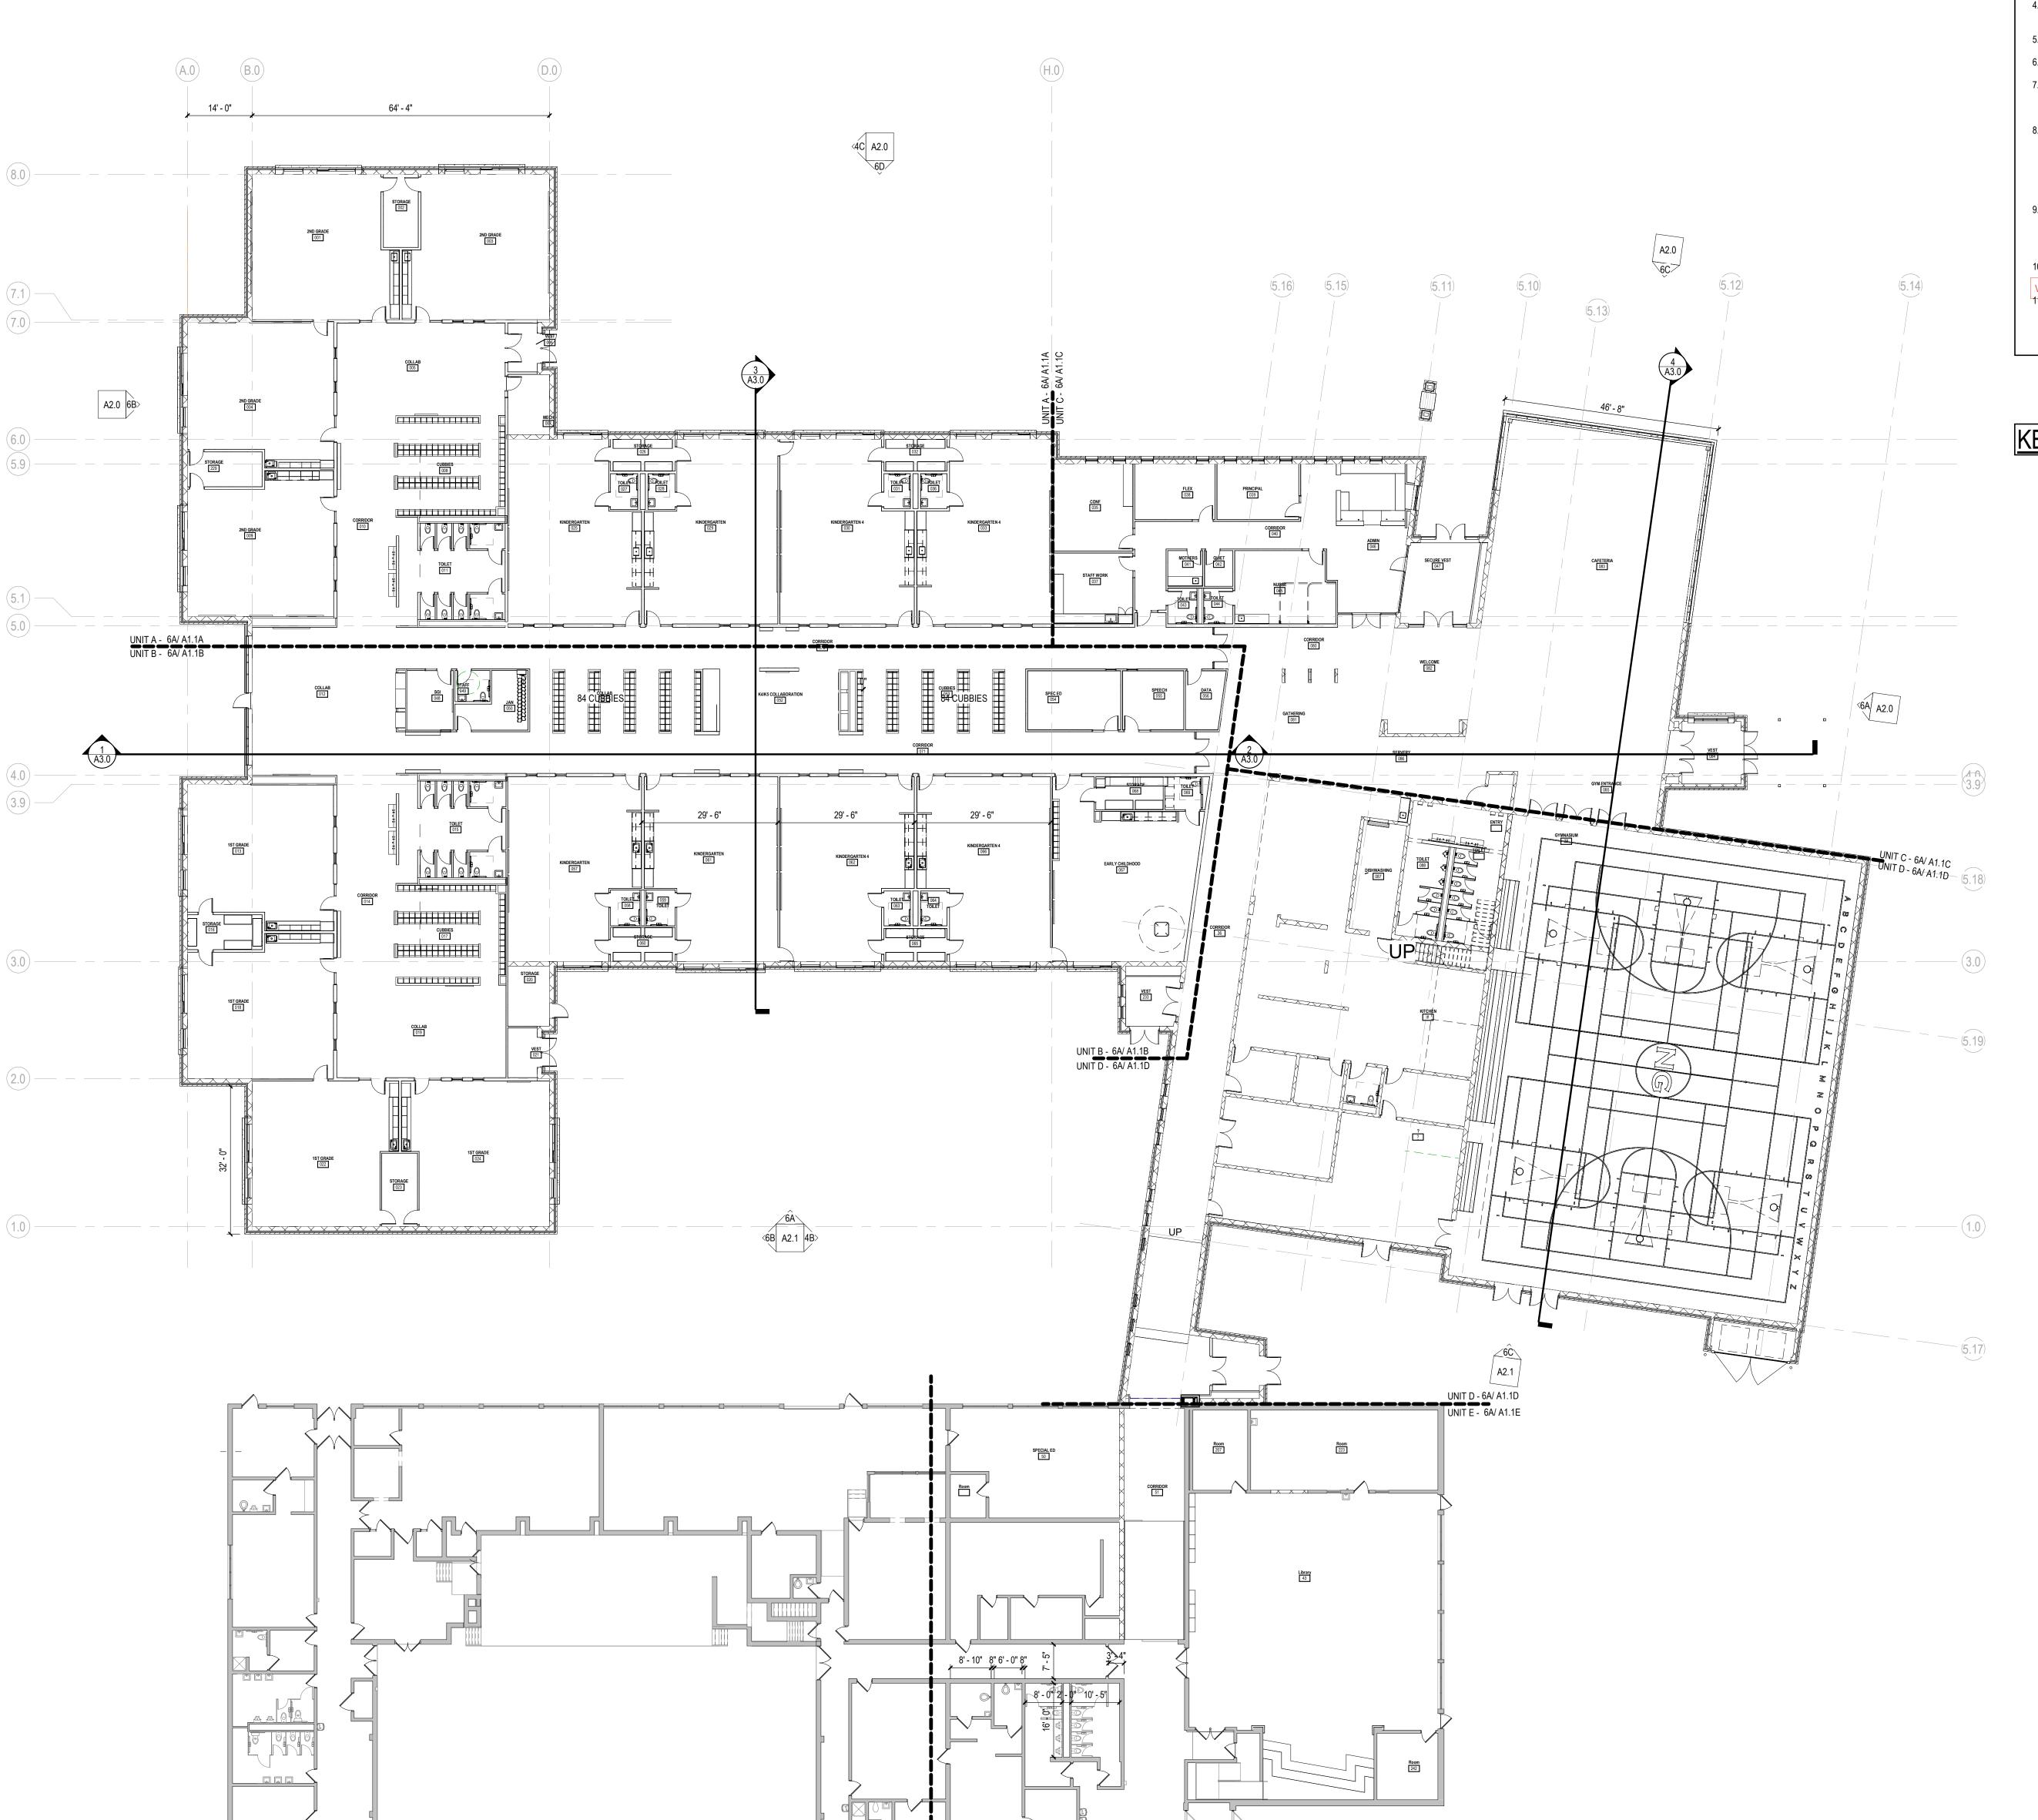

GENERAL NOTES

- DO NOT SCALE FROM DRAWINGS.
- EXISTING CONDITIONS: EXISTING CONDITIONS SHOWN ON DRAWINGS REPRESENT CURRENT BUILDING. IT IS THE RESPONSIBILITY OF THE CONTRACTOR TO FIELD VERIFY EXISTING CONDITIONS PRIOR TO PERFORMING WORK. REPORT ANY DISCREPANCIES TO THE ARCHITECT FOR REVIEW. WORK DONE WITHOUT RESOLUTION OF DISCREPANCIES MUST BE REDONE AT THE REQUEST OF THE ARCHITECT AT NO ADDITIONAL COST TO THE CONTRACT.
- REFER TO SHEET AG1.0 FOR WALL TYPES. REFER TO SHEET G0.1 FOR RATED WALL
- 4. REFER TO SHEET AG1.0 FOR TYPICAL MOUNTING HEIGHTS. REFER TO INTERIOR ELEVATION SHEETS FOR ROOM SPECIFIC FIXTURE MOUNTING HEIGHTS.
- 5. REFER TO SHEET A9.0 FOR FLOOR TRANSITION DETAILS.
- 6. REFER TO SHEET A9.0 FOR TYPICAL FLOOR/BASE CONDITIONS.
- 7. DIMENSIONS FOR INTERIOR STUD WALLS ARE TO FACE OF WALL. EXTERIOR STUD WALLS ARE DIMENSIONED TO INTERIOR FACE OF STUDS. CMU WALLS ARE DIMENSIONED TO FACE OF
- 8. IDENTIFY ALL RATED WALLS AND PARTITIONS WITH PAINTED LETTERING THAT READS "FIRE AND/OR SMOKE BARRIER PROTECT ALL OPENINGS" ABOVE CEILINGS. LETTERING TO BE LOCATED WITHIN 15 FEET OF THE END OF EACH WALL AND AT INTERVALS NOT EXCEEDING 30'-0" O.C. HORIZONTALLY, BOTH SIDES OF WALL. LETTERING TO BE NOT LESS THAN 3" IN HEIGHT WITH A 3/8" MINIMUM STROKE IN A CONTRASTING COLOR. SEE SHEET G0.1 PLANS FOR LOCATION OF RATED WALLS.
- 9. REFER TO STRUCTURAL DRAWINGS FOR FIREPROOFING LOCATIONS. PROVIDE INTUMESCENT PAINT AT EXPOSED STEEL COLUMNS AND AT THE BOTTOM FLANGE OF STEEL LINTELS. PROVIDE SPRAYED FIRE-RESISTIVE MATERIAL AT STEEL BEAMS, ROOF DECK AND ROOF JQISTS UNLESS NOTED OTHERWISE.
- COORDINATE TO BE SURE CORRECT LOCATIONS AND RATINGS ARE SHOWN.

 10. REFER TO REFLECTED CEILING PLANS & CLERESTORY PLANS FOR LOCATION OF ALL WINDOW TREATMENTS.
- VERIFY WINDOW TREATMENTS ARE SHOWN ON RCP'S AND TAGS HAVE BEEN COORDINATED WITH THE IF

 11. REQUIRED MEANS OF EGRESS FROM THE EXISTING BUILDING SHALL BE MAINTAINED AT ALL

 TIMES DURING CONSTRUCTION WHEN THE BUILDING REMAINS OCCUPIED. IN THE EVENT THAT

 AN EXISTING MEANS OF EGRESS CANNOT BE MAINTAINED, CONTRACTOR SHALL PROVIDE AN

 APPROVED TEMPORARY MEANS OF EGRESS.

KEYNOTE LEGEND

KEY PLAN



Milwaukee 829 South 1st Street Milwaukee, Wisconsin 53204 T: 414.226.0200

Sheboygan • Davenport • Moline

www.brayarch.com

New Glarus Primary School New Glarus School District 1420 2nd St New Glarus, WI 53574

REVISIONS:

A DATE DESCRIPTION

DATE DESCRIPT

T FOR NSTRUCTION

Project Number: 3388.6

Issued For:
SCHEMATIC

DESIGN
16 JUNE 2023

Sheet Title:

OVERALL FIRST

FLOOR PLAN

Sheet Number:

A1.1

© 2020 Bray Associates Architects, Inc.

6A FIRST FLOOR OVERAL Scale: 1/16" = 1'-0"



Milwaukee 829 South 1st Street Milwaukee, Wisconsin 53204 T: 414.226.0200

www.brayarch.com

REVISIONS:

DATE DESCRIPTION

Project Number: 3388.6


SCHEMATIC DESIGN 16 JUNE 2023

Sheet Title: ARCH SITE PLAN

Sheet Number:

© 2020 Bray Associates Architects, Inc.

© 2020 Bray Associates Architects, Inc.

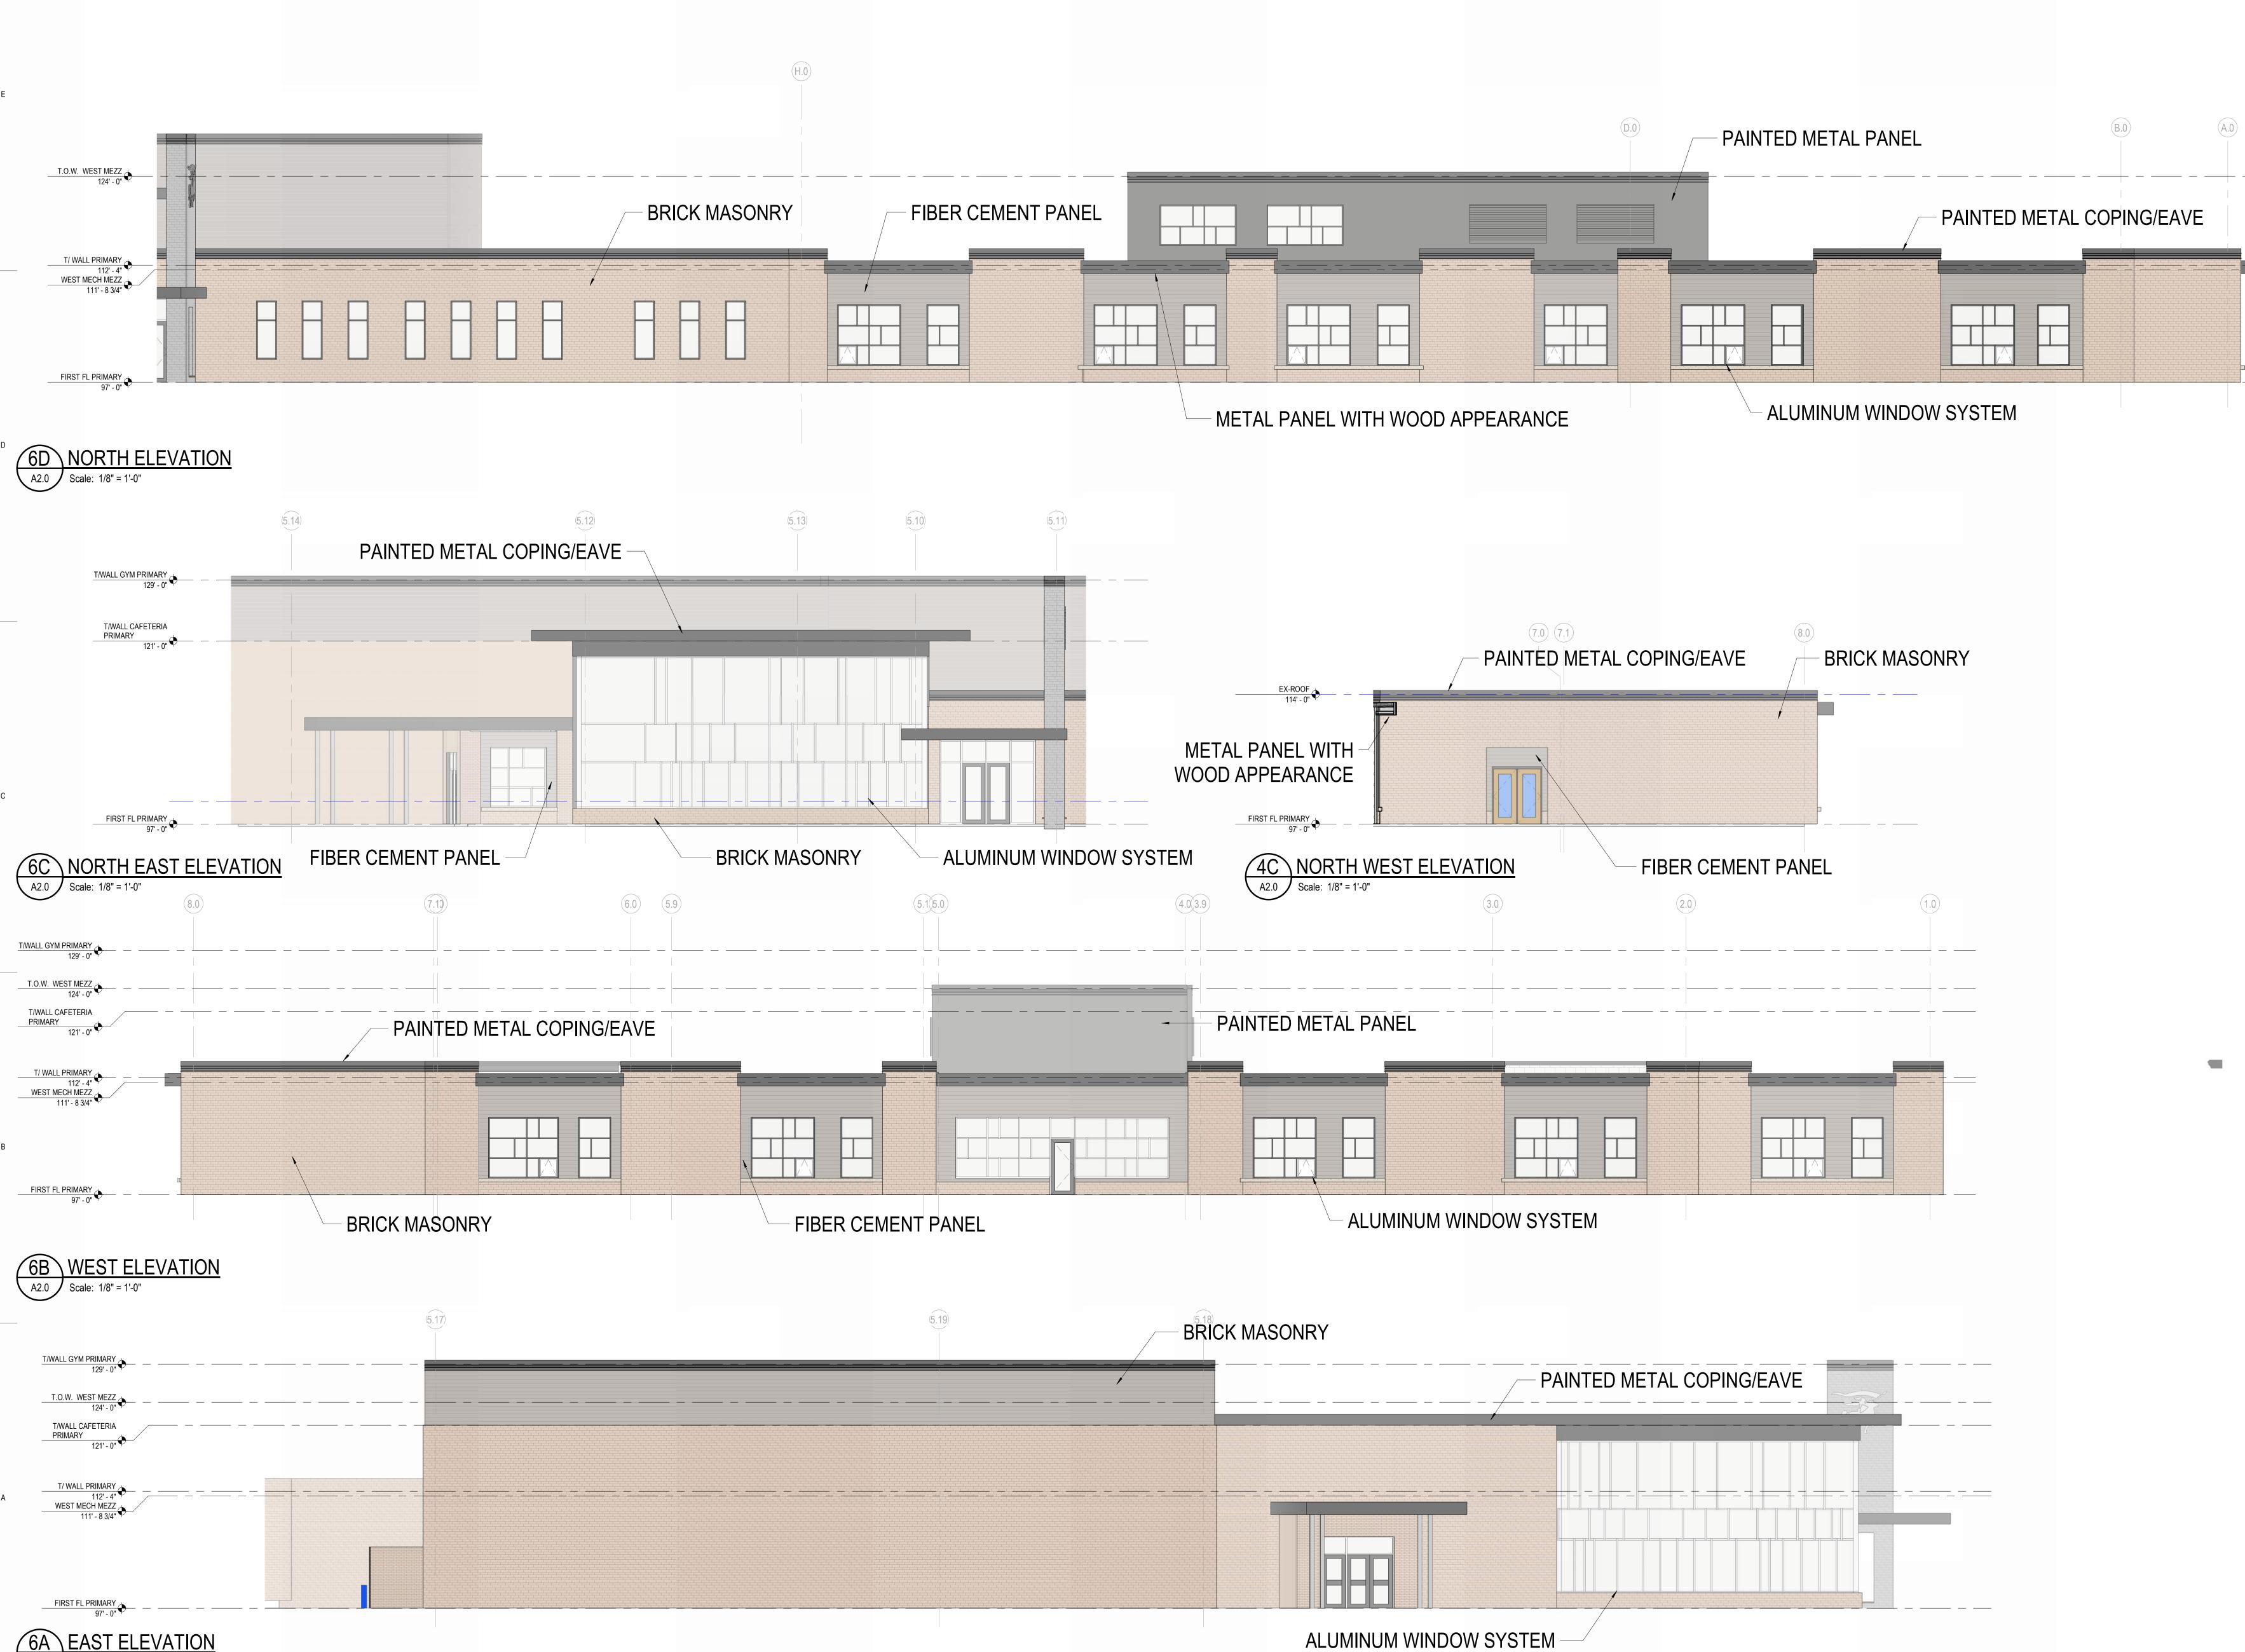



829 South 1st Street Milwaukee, Wisconsin 53204 T: 414.226.0200

www.brayarch.com

REVISIONS: # DATE DESCRIPTION

NOT FOR CONSTRUCTION

Project Number: 3388.6

SCHEMATIC

DESIGN 16 JUNE 2023

Sheet Title: **OVERALL EXTERIOR ELEVATIONS**

Sheet Number:

© 2020 Bray Associates Architects, Inc.

A2.1

T.O.W. WEST MEZZ 124' - 0" - PAINTED METAL PANEL PAINTED METAL COPING/EAVE T/ WALL PRIMARY
112' - 4"
WEST MECH MEZZ
111' - 8 3/4" - ALUMINUM WINDOW SYSTEM BRICK MASONRY - FIBER CEMENT PANEL 6A SOUTH ELEVATION - 1

EX FIRST FLOOR
100' - 0" FIRST FL PRIMARY 97' - 0" Scale: 1/8" = 1'-0"

PAINTED METAL COPING/EAVE FIBER CEMENT PANEL EX-ROOF 114' - 0" T/ WALL PRIMARY 112' - 4" METAL PANEL WITH WOOD APPEARANCE EX FIRST FLOOR FIRST FL PRIMARY 97' - 0" 6B SOUTH WEST ELEVATION

A2.1 Scale: 1/8" = 1'-0" - ALUMINUM BRICK WINDOW SYSTEM MASONRY

EX FIRST FLOOR 100' - 0"

METAL PANEL WITH WOOD APPEARANCE

BRICK MASONRY

Scale: 1/8" = 1'-0"

ALUMINUM WINDOW SYSTEM